

ABBREVIATIONS: WHEN USED IN THESE DOCUMENTS SHALL CONFORM TO THE FOLLOWING LIST UNLESS OTHERWISE NOTED. DRAWINGS OF OTHER DISCIPLINES (SUCH AS CIVIL, STRUCTURAL, PLUMBING, MECHANICAL, AND ELECTRICAL) MAY CONTAIN SPECIFIC ABBREVIATIONS, REFERENCES, AND LEGENDS WITH INTERPRETATION INTENDED ONLY FOR THOSE DISCIPLINES.

& L	AND ANGLE	F.E.J.	FIBER EXPANSION JOINT	O.H.W.S.	OVAL HEAD WOOD SCREW
@	AT	F.F.	FACTORY FINISH	OPNG.	OPENING
⊕	CENTERLINE	F.F.LR.	FINISH FLOOR	OPP.	OPPOSITE
⊖	DIAMETER OR ROUND PERPENDICULAR	F.G.	FINISH GRADE	O/	OVER
⊙	ROUND OR NUMBER	F.H.	FIRE HYDRANT	ORIG.	ORIGINAL
(E)	EXISTING	F.H.M.	FLAT HEAD MACHINE SCREW	OVHD	OVER HEAD
(N)	NEW	FHWS	FLAT HEAD WOOD SCREW	OWJ	OPEN WEB JOIST
ABV.	ABOVE	FIN.	FINISH	P.B.N.	PLYWOOD BOUNDARY NAILING
A/C	AIR CONDITIONING	FIXT.	FIXTURE	P.E.N.	PLYWOOD EDGE NAILING
ACC.	ACCESSIBLE	FLR.	FLOOR(ING)	P.E.S.	PLYWOOD EDGE SCREWS
ACP	ASPHALT CONCRETE	FLASH.	FLASHING	P.I.V.	POST INDICATOR VALVE
ACST.	ACOUSTICAL	FLUOR.	FLUORESCENT	P.LAM.	PLASTIC LAMINATE
A.C.T.	ACOUSTIC CEILING TILE	F.O.	FACE OF	P.L.	PROPERTY LINE
A.B.	ANCHOR BOLT	F.O.C.	FACE OF CONCRETE	PL.	PLATE
ADA	AMERICANS WITH DISABILITIES ACT	F.O.F.	FACE OF FINISH	PLAS.	PLASTER
ADAAG	ADA ACCESSIBLE GUIDELINES	F.O.M.	FACE OF MASONRY	PLYWD.	PLYWOOD
ADDL.	ADDITIONAL	F.O.S.	FACE OF STUD	PR.	POUNDS PER SQUARE FOOT
ADJ.	ADJUSTABLE	FRP	FIBERGLASS REINFORCED PANELING	PSF	POUNDS PER SQUARE FOOT
ADJC.	ADJACENT	F.S.	FIRE SPRINKLER(S)	PSI	POUNDS PER SQUARE INCH
A.F.F.	ABOVE FINISH FLOOR	F.S.H.	FIRE SPRINKLER HEAD	PT.	POINT
A.F.C.	ABOVE FINISH GRADE	FT.	FOOT/FEET	P.T.D.	PAPER TOWEL DISP.
AGG.	AGGREGATE	FURR.	FURRING	P.T.D.F.	PRESSURE TREATED
ALT.	ALTERNATE	FUT.	FUTURE	R.	RADIUS
ALUM.	ALUMINUM	GA.	GAUGE	R.	THERMAL RESISTANCE
ANOD.	ANODIZED	GALV.	GALVANIZED	R.A.	RETURN AIR
A.P.C.	ACOUSTIC PANEL CEILING	G.B.	GRAB BAR	R.D.	ROOF DRAIN
APPROX.	APPROXIMATE	G.C.	GENERAL CONTR.	REFL.	REFLECTED
ARCH.	ARCHITECT(URAL)	GEN.	GENERAL	REFR.	REFRIGERATOR
AV	AUDIO VISUAL	G.I.	GALVANIZED IRON SHEET METAL	REINF.	REINFORCED
BD.	BOARD	G.I.S.M.	GALVANIZED IRON SHEET METAL	REM.	REMOVE
BEL.	BELOW	GL.	GLASS	REOD.	REQUIRED
B.E.N	BOUNDARY EDGE NAILING	GND.	GROUND	RESIL.	RESILIENT
BLDG.	BUILDING	GR.	GRADE	R.H.	RIGHT HAND
BLK.	BLOCK	GYP.	GYPSPUM	R.H.W.S.	ROUND HEAD WOOD SCREW
BLKG.	BLOCKING	H.B.	HOSE BIBB	RM.	ROOM
BM.	BEAM	HBD.	HARDBOARD	R.O.	ROUGH OPENING
BOT.	BOTTOM	H.C.	HOLLOW CORE	R.O.W.	RIGHT-OF-WAY
BRG.	BEARING	HD.	HEAD	RWD.	REDWOOD
BTWN.	BETWEEN	H.D.	HEAVY DUTY	RWL	RAIN WATER LEADER
B.U.R.	BUILT-UP ROOF(ING)	HDR.	HEADER	R.	RADIUS
C&G	CURB AND GUTTER CABINET	HDW.	HARDWARE	R.	THERMAL RESISTANCE
C.B.	CARRIAGE BOLT	HDWD.	HARDWOOD	R.A.	RETURN AIR
CEM.	CEMENT	H.M.	HOLLOW METAL	R.D.	ROOF DRAIN
CER.	CERAMIC	H.M.D.	HOLLOW METAL DOOR	REFL.	REFLECTED
C.F.	CUBIC FOOT	H.M.F.	HOLLOW METAL FRAME	REFR.	REFRIGERATOR
C.I.	CAST IRON	HORIZ.	HORIZONTAL	REINF.	REINFORCED
C.I.	CONSTRUCTION JOINT	HR.	HOUR	REM.	REMOVE
C.L.	CENTER LINE	HT.	HEIGHT	REOD.	REQUIRED
C.L.F.	CHAIN LINK FENCE	HVAC	HEATING/VENTILATING/AIR CONDITONING	RESIL.	RESILIENT
CLG.	CEILING	HWY	HIGH WAY	R.H.	RIGHT HAND
C.L.O.	CLOSET	I.D.	INSIDE DIAMETER/ DIMENSION	R.H.W.S.	ROUND HEAD WOOD SCREW
CLR.	CLEAR	INFO	INFORMATION	RM.	ROOM
CLRM.	CLASS ROOM	INSUL.	INSULATION	R.O.	ROUGH OPENING
CMU	CONCRETE MASONRY UNIT	INT.	INTERIOR	R.O.W.	RIGHT-OF-WAY
CTR.	COUNTER	JAN.	JANITOR	RWD.	REDWOOD
C.O.	CLEAN OUT	JT.	JOINT	RWL	RAIN WATER LEADER
COL.	COLUMN	KIT.	KITCHEN	R.	RADIUS
CONC.	CONCRETE	K.O.	KNOCK OUT	R.	THERMAL RESISTANCE
CONN.	CONNECTION	K.O.P.	KNOCK OUT PANEL	R.A.	RETURN AIR
CONSTR.	CONSTRUCTION	LAB.	LABORATORY	R.D.	ROOF DRAIN
CONT.	CONTINUOUS	LAM.	LAMINATE	REFL.	REFLECTED
CONTR.	CONTRACTOR	LAV.	LAVATORY	REFR.	REFRIGERATOR
CPT.	CARPET	LB(S)	POUND (POUNDS)	REINF.	REINFORCED
CRC	COLD ROLLED CHANNEL CENTER	L.B.	LAG BOLT	REM.	REMOVE
CTR.	CENTER	L.F.	LINEL FOOT	REOD.	REQUIRED
CTSK	COUNTERSUNK	L.H.	LEFT HAND	RESIL.	RESILIENT
C.Y.	CUBIC YARD	LIB.	LIBRARY	R.H.	RIGHT HAND
D.A.	DISABLED ACCESS	LT.	LIGHT	R.H.W.S.	ROUND HEAD WOOD SCREW
DBL.	DOUBLE	LT.WT.	LIGHT WEIGHT	RM.	ROOM
DEMO	DEMOLISH/ DEMOLITION	MACH.	MACHINE	R.O.	ROUGH OPENING
D.F.	DRINKING FOUNTAIN OR DOUGLAS FIR	MAINT.	MAINTENANCE	R.O.W.	RIGHT-OF-WAY
DET.	DETAIL	MAX.	MAXIMUM	RWD.	REDWOOD
DIAG.	DIAGONAL	M.B.	MACHINE BOLT	RWL	RAIN WATER LEADER
DIA.	DIAMETER	M.B.M.	METAL BUILDING MANUFACTURER	R.	RADIUS
DIM.	DIMENSION	MECH.	MECHANICAL	R.	THERMAL RESISTANCE
DISP.	DISPENSER	MED.	MEDIUM	R.A.	RETURN AIR
DN.	DOWN	MEMB.	MEMBRANE	R.D.	ROOF DRAIN
DP.	DEEP	MTL.	METAL	REFL.	REFLECTED
DS	DOWN SPOUT	MFR.	MANUFACTURER	REFR.	REFRIGERATOR
DWG(S)	DRAWING	MH.	MANHOLE	REINF.	REINFORCED
DWR.	DRAWER	MKR.	MARKER	REM.	REMOVE
E	EAST	MIN.	MINIMUM	REOD.	REQUIRED
E.A.	EACH	MISC.	MISCELLANEOUS	RESIL.	RESILIENT
E.F.	EXHAUST FAN	M.O.	MASONRY OPENING	R.H.	RIGHT HAND
EGR.	ENGINEER	MTD.	MOUNTED	R.H.W.S.	ROUND HEAD WOOD SCREW
E.J.	EXPANSION JOINT	MTG.	MEETING	RM.	ROOM
EL.	ELEVATION	MULL.	MULLION	R.O.	ROUGH OPENING
ELEC.	ELECTRICAL	N	NORTH	R.O.W.	RIGHT-OF-WAY
ELEV.	ELEVATOR	N.I.C.	NOT IN CONTRACT	RWD.	REDWOOD
EMB.	EMBEDMENT	NO.	NUMBER	RWL	RAIN WATER LEADER
EMER.	EMERGENCY	NOM.	NOMINAL	R.	RADIUS
E.N.	EDGE NAILING	N.R.C.	NOISE REDUCTION COEFFICIENT	R.	THERMAL RESISTANCE
ENCL.	ENCLOSURE	N.T.S.	NOT TO SCALE	R.A.	RETURN AIR
EQ.	EQUAL	O.C.	ON CENTER	R.D.	ROOF DRAIN
EQUIP.	EQUIPMENT	O.D.	OUTSIDE DIAMETER/ DIMENSION	REFL.	REFLECTED
EVAP.	EVAPORATIVE	OFF.	OFFICE	REFR.	REFRIGERATOR
E.W.	EACH WAY	OFCI	OWNER FURNISHED, CONTR. INSTALLED	REINF.	REINFORCED
EXH.	EXHAUST	OFOI	OWNER FURNISHED, OWNER INSTALLED	REM.	REMOVE
EXST.	EXISTING	O.F.R.D.	OVER FLOW ROOF DRAIN	REOD.	REQUIRED
EXP.	EXPANSION	O.H.	OPPOSITE HAND	RESIL.	RESILIENT
EXT.	EXTERIOR	O.H.C.D.	OVER HEAD COILING DOOR	R.H.	RIGHT HAND
FA	FIRE ALARM	O.H.M.S.	OVAL HEAD MACH. SCREW	R.H.W.S.	ROUND HEAD WOOD SCREW
F.B.	FLAT BAR			RM.	ROOM
F.B.O.	FURNISHED BY OWNER/OTHERS			R.O.	ROUGH OPENING
F.D.	FLOOR DRAIN			R.O.W.	RIGHT-OF-WAY
F.D.C.	FIRE DEPARTMENT CONNECTION			RWD.	REDWOOD
FDN.	FOUNDATION			RWL	RAIN WATER LEADER
F.E.	FIRE EXTINGUISHER			R.	RADIUS
F.E.C.	FIRE EXTINGUISHER CABINET			R.	THERMAL RESISTANCE

CODES AND ORGANIZATIONS	
CBC	CALIFORNIA BUILDING CODE
CEC	CALIFORNIA ELECTRICAL CODE
CFE	CALIFORNIA FIRE CODE
CMC	CALIFORNIA MECHANICAL CODE
CPC	CALIFORNIA PLUMBING CODE
ICC	INTERNATIONAL CODE COUNCIL DIVISION OF THE STATE ARCHITECT
NSF	NATIONAL SANITATION FOUNDATION
NFPA	NATIONAL FIRE PROTECTION ASSOCIATION
NEC	NATIONAL ELECTRICAL CODE
IBC	INTERNATIONAL BUILDING CODE
IFC	INTERNATIONAL FIRE CODE
IMC	INTERNATIONAL MECHANICAL CODE
IPC	INTERNATIONAL PLUMBING CODE

ABBREVIATIONS

PROJECT DIRECTORY

GENERAL INFORMATION

SHADE STRUCTURE FOR BURRIS PARK AMPHITHEATER KING COUNTY BURRIS PARK KINGSBURG, CA

FOR THE BURRIS PARK FOUNDATION DESIGN BUILD SCOPE - BRIDGING DOCUMENTS

OWNER
BURRIS PARK FOUNDATION

P.O. BOX 571
HANFORD, CA 93232

CONTACT: SHARLENE BOGAN
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FRESNO, CA 93711
(559) 437-0887

CONTACT: LOREN K. AITON
EMAIL: loren.aiton@teterae.com

GENERAL

PROJECT ADDRESS:
6500 CLINTON AVE.
KINGSBURG, CA 93631

PROJECT DESCRIPTION

PROJECT CONSISTS OF CONSTRUCTING THE FOLLOWING AT BURRIS COUNTY REGIONAL PARK.

1. PREFABRICATED FABRIC SHADE STRUCTURE, INCLUDING STRUCTURAL SUPPORTS AT EXISTING AMPHITHEATER.

DEFERRED SUBMITTALS

MANUFACTURER'S SUBMITTAL DRAWINGS AND CALCULATIONS FOR PREFABRICATED FABRIC SHADE STRUCTURE INCLUDING DESIGN OF ALL REQUIRED COMPONENTS INCLUDING FOUNDATIONS AND STEEL STRUCTURE, FABRIC SYSTEM AND SUPPORT CABLING.

GOVERNING CODES

2022 CALIFORNIA BUILDING STANDARDS ADMINISTRATIVE CODE (CAC), PART 1, TITLE 24 C.C.R.
2022 CALIFORNIA BUILDING CODE (CBC), PART 2, TITLE 24 C.C.R.
2022 CALIFORNIA ELECTRICAL CODE (CEC), PART 3, TITLE 24 C.C.R.
2022 CALIFORNIA MECHANICAL CODE (CMC), PART 4, TITLE 24 C.C.R.
2022 CALIFORNIA PLUMBING CODE (CPC), PART 5, TITLE 24 C.C.R.
2022 CALIFORNIA ENERGY CODE (CEC), PART 6, TITLE 24 C.C.R.
2022 CALIFORNIA FIRE CODE (CFC), PART 9, TITLE 24 C.C.R.
2022 CALIFORNIA GREEN BUILDING STANDARD CODE (CALGREEN), PART II, TITLE 24 C.C.R.
2022 CALIFORNIA REFERENCED STANDARDS, PART 12, TITLE 24 C.C.R.
2022 TITLE 19 C.C.R., PUBLIC SAFETY, STATE FIRE MARSHAL REGULATIONS
NFPA 12 NATIONAL FIRE CODE (2016 EDITION-CA AMENDED)
2010 AMERICANS WITH DISABILITIES ACT

BUILDING DATA

AMPHITHEATER BASIC ALLOWABLE HEIGHT & BUILDING AREAS (CBC 2016, CHAPTER 5, TABLE 502)

CONSTRUCTION TYPE: V-B

BASE ALLOWABLE AREA: UNLIMITED

BUILDING AREA: 4,104 SF

OCCUPANCY CLASSIFICATIONS: A-5

EXISTING SEATING CAPACITY: 101 PERSONS

EXISTING ACCESSIBLE WHEELCHAIR SEATING SPACES PROVIDED: 4


ALLOWABLE HEIGHT (ABOVE GRADE): 40'

SHADE HEIGHT: +/- 12'

PROJECT SHALL CONSIST OF A STEEL AND FABRIC SHADE STRUCTURE OVER THE EXISTING AMPHITHEATER. NO NEW SEATING OR OTHER FEATURES ARE INCLUDED IN THIS SCOPE.

GENERAL	
6000	COVER SHEET
6001	CAL GREEN REQUIREMENTS
ARCHITECTURAL	
A100	PARTIAL SITE PLAN - GREENHOUSE
A101	PARTIAL SITE PLAN - AMPHITHEATER

SHEET INDEX

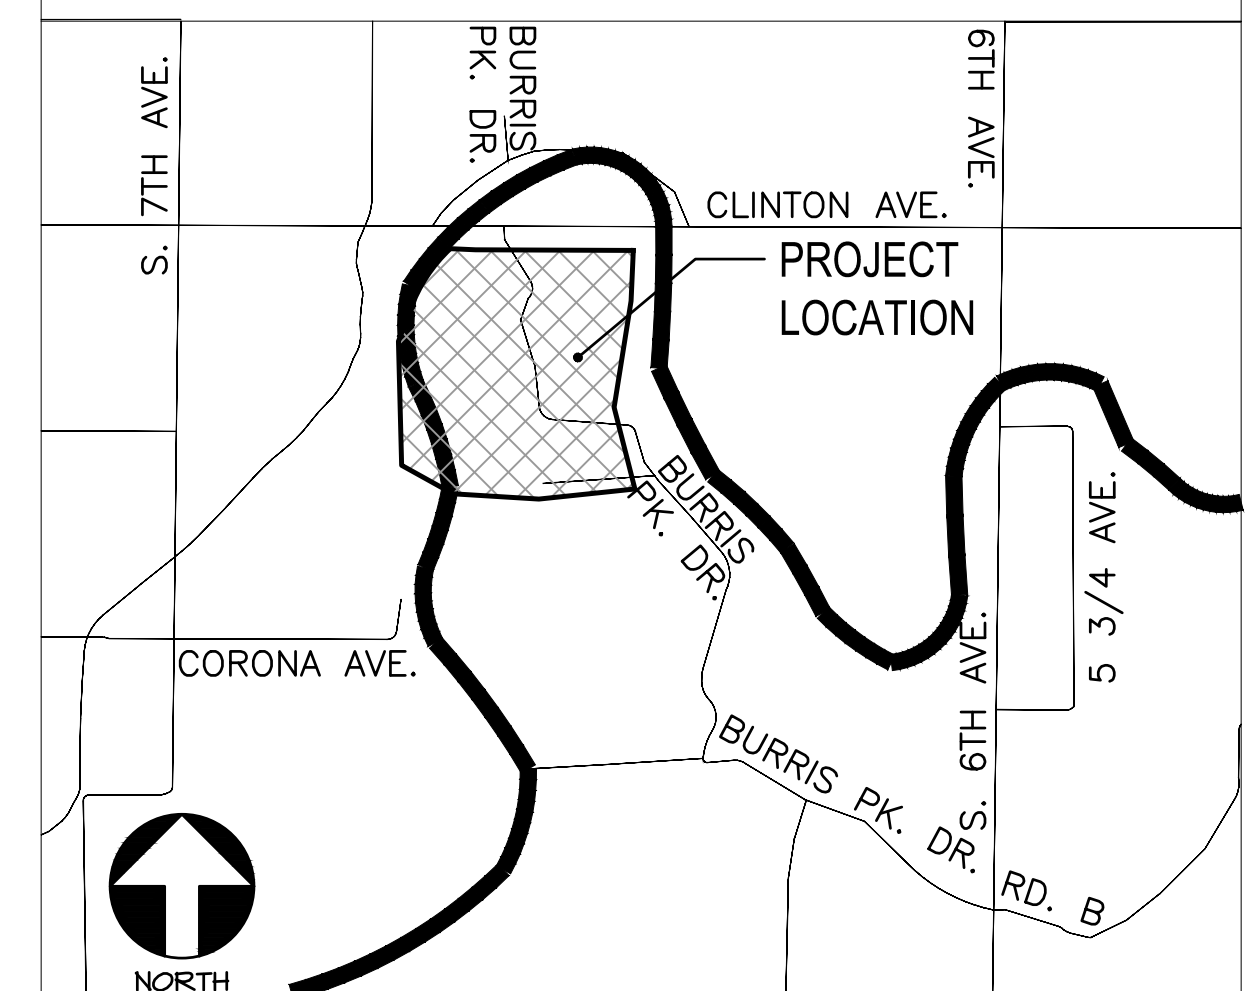


PROJECT LOCATION

SCALE: N.T.S.

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ARCHITECTS ENGINEERS CONNECTED

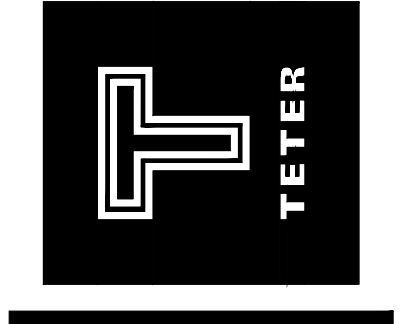

**NEW SHADE STRUCTURE
AT EXISTING AMPHITHEATER
BURRIS PARK FOUNDATION
KINGSBURG, CA**
DRAWING TITLE
COVER SHEET

PROJECT NO.
23-12742

DRAWING
G000

PLOT DATE: 1/27/23

CALGREEN REQUIREMENTS CHECKLIST

CALIFORNIA GREEN BUILDING STANDARDS CODE 2022
NON-RESIDENTIAL MANDATORY MEASURES



Project Name: Burris Park Amphitheater Fabric Shade Structure
Project Number: 23-12792
Date: 7/26/2023

Chapter 5 - NONRESIDENTIAL MANDATORY MEASURES

DIVISION 5.1 - PLANNING AND DESIGN

Code Section	Requirement	Phase	Discipline	Sheet Reference Spec Reference	Comments
5.106.1.1	Local Ordinance (Stormwater Management)	N/A			Project does not present any grading work.
5.106.1.2	Best Management Practices (BMP) <1 Acre	N/A			Project does not present any grading work.
5.106.2	Stormwater Pollution Prevention Plan >1 Acre	N/A			Project Area less than 1 Acre
5.106.4.1	Bicycle Parking	N/A			Alteration, no new parking proposed
5.106.4.1.1	Short-Term Bicycle Parking	N/A			
5.106.4.1.2	Bicycle Parking	N/A			Alteration, no tenant spaces
5.106.4.1.3	Long-Term Bicycle Parking (A)	N/A			No new tenant vehicular parking spaces added
5.106.4.1.4	Long-Term Bicycle Parking Shell Bldgs	N/A			Project is a shade structure, no parking associated
5.106.4.2	Bicycle Parking (DSA-SS)	N/A			Project is located on County Regional Park
5.106.5.3	Electric Vehicle (EV) Charging (N)	N/A			Project is limited to fabric shade structure over existing amphitheater. No parking is associated with this project
5.106.5.3.1	EV Capable Spaces (N) EVSE & EVSC	N/A			No EV parking provided
5.106.5.3.2	Electric Vehicle Charging Stations (EVCS) including EVSE Spaces	N/A			No EV parking provided
5.106.5.3.3	Automatic Load Management Systems (ALMS)	N/A			No EV parking provided
5.106.5.3.4	Accessible EVCS (CBC 11B-228.3)	N/A			No EV parking provided
5.106.5.4	EV Charging - Medium and Heavy Duty (N) including EVSE Spaces	N/A			Not applicable to this project type
5.106.5.3.4.1	EV Readiness for Warehouse, Grocery and Retail Stores	N/A			Not applicable to this project type
5.106.8	Light Pollution Reduction	N/A			No Exterior lighting associated with this project
5.106.10	Grading & Paving	N/A			Project will not disturb existing drainage
5.106.12	Shade Trees (DSA-SS)	N/A			Project is a fabric shade structure
5.106.12.1	Surface Parking Areas	N/A			Project does not include any parking
5.106.12.2	Landscape Areas	N/A			Project is located in a regional park with established trees for shade
5.106.12.3	Hardscape Areas	N/A			No hardscape improvements within project scope

DIVISION 5.2 - ENERGY EFFICIENCY

Code Section	Requirement	Phase	Discipline	Sheet Reference Spec Reference	Comments
5.201.1	California Energy Code Mandatory Building Standards	N/A			Project does not include any lighting or power usage

DIVISION 5.3 - WATER EFFICIENCY AND CONSERVATION

Code Section	Requirement	Phase	Discipline	Sheet Reference Spec Reference	Comments
5.303.1.1	Meters - New Buildings or Additions in Excess of 50,000 S.F.	N/A			Project does not include any plumbing
5.303.1.2	Meters - Excess Consumption	N/A			Project does not include any plumbing
5.303.3	Water Conserving Plumbing Fixtures and Fittings	N/A			Project does not include any plumbing
5.303.3.1	Water Closets	N/A			
5.303.3.2	Urinals	N/A			
5.303.3.3	Showers	N/A			
5.303.3.4.1	Nonresidential Lavatory Faucets	N/A			
5.303.3.4.2	Kitchen Faucets & Fountains	N/A			
5.303.3.4.3	Wash Fountains	N/A			
5.303.3.4.4	Metering Faucets	N/A			
5.303.3.4.5	Meter Faucets for wash fountains	N/A			
5.303.3.4.6	Pre-rinse spray valve	N/A			

5.303.4.1	Food Waste Disposers	N/A			
5.304.1	Outdoor Potable Water Use	N/A			Project scope does not include any landscaping
5.304.6	Outdoor Potable Water Use	N/A			Project scope does not include any landscaping
5.304.6.1	Newly Constructed Landscapes				Project scope does not include any landscaping
5.304.6.2	Rehabilitated Landscapes				Project scope does not include any landscaping

DIVISION 5.4 - MATERIAL CONSERVATION AND RESOURCE EFFICIENCY

Code Section	Requirement	Phase	Discipline	Sheet Reference Spec Reference	Comments
5.407.1	Weather Protection	N/A			Project is not a building
5.407.2.1	Moisture Control - Sprinklers	N/A			Project is not a building
5.407.2.2	Moisture Control - Entries & Openings	N/A			Project is not a building
5.407.2.2.2	Flashing	N/A			Project is not a building
5.408.1.1	Construction Waste Management Plan		C		Contractor to prepare plan to address any site generated construction waste
5.408.1.2	Waste Management Company		C		
5.408.1.3	Waste Stream Reduction Alternative		C		
5.408.1.4	Construction Waste Management Plan: Documentation		C		Contractor to prepare record of onsite generated construction waste and waste diverted to recycling
5.408.2	Universal Waste (A)	N/A			Project does not include any universal waste items
5.408.3	Excavated Soil & Land Clearing Debris	N/A			Project included only foot excavation with no land creating anticipated
5.410.1	Recycling By Occupants	N/A			Project does not include any occupants
5.410.2	Commissioning (buildings > 10,000 SF)	N/A			Open air exterior project, No HVAC system included
5.410.2.1	Owner's Project Requirements (OPR)	N/A			Open air exterior project, No HVAC system included
5.410.2.2	Basis of Design (BOD)	N/A			Open air exterior project, No HVAC system included
5.410.2.3	Commissioning Plan	N/A			Open air exterior project, No HVAC system included
5.410.2.4	Functional Performance Testing	N/A			Open air exterior project, No HVAC system included
5.410.2.5	Documentation and Training	N/A			Open air exterior project, No HVAC system included
5.410.4	Testing & Adjusting (Buildings < 10,000 SF)	N/A			Open air exterior project, No HVAC system included

DIVISION 5.5 - ENVIRONMENTAL QUALITY


Code Section	Requirement	Phase	Discipline	Sheet Reference Spec Reference	Comments
5.503.1	Fireplaces	N/A			None included in Scope
5.503.1.1	Woodstoves	N/A			None included in Scope
5.504.1.3	Temporary Ventilation	N/A			Not Required
5.504.3	Covering of Duct Openings & Protection of Mechanical Equipment During Construction	N/A			Not Required
5.504.4	Finish Material Pollutant Control	N/A			None included in Scope
5.504.4.1	Adhesives, Sealants, Caulks	N/A			None included in Scope
5.504.4.3.1	Paints & Coatings	N/A			None included in Scope
5.504.4.3.1	Paints & Coatings: Aerosol Paints & Coatings	N/A			None included in Scope
5.504.4.3.2	Paints & Coatings: Verification	N/A			None included in Scope
5.504.4.4	Carpet Systems	N/A			None included in Scope
5.504.4.4.1	Carpet Systems - Carpet Cushion	N/A			None included in Scope
5.504.4.4.2	Carpet Systems - Carpet Adhesive	N/A			None included in Scope
5.504.4.5	Composite Wood Products	N/A			None included in Scope
5.504.4.6	Resilient Flooring Systems	N/A			None included in Scope
5.504.4.7	Thermal Insulation	N/A			None included in Scope
5.504.4.8	Acoustical ceilings and wall panels	N/A			None included in Scope
5.504.5.3	Filters	N/A			None included in Scope
5.504.7	Environmental Tobacco Smoke (ETS) Control	N/A			County Park is designated No Smoking Facility
5.505.1	Indoor Moisture Control	N/A			Not Required
5.506.1	Outside Air Delivery	N/A			Not Required
5.506.2	Carbon Dioxide (CO2) Monitoring	N/A			Not Required
5.506.3	CO2 Monitoring in Classrooms (DSA-SS)	N/A			Not Required
5.507.4.1	Acoustical Control - Exterior Noise Transmission	N/A			Project not located within a 65db CNEL Zone
5.507.4.3	Acoustical Control - Interior Sound	N/A			None included in Scope
5.508.1	Ozone depletion and global warming reductions (no CFCs and Halons)	N/A			None included in Scope
5.508.2	Supermarket refrigerant leak reduction	N/A			None included in Scope

Phase Description	Discipline Abbreviations
Design	O - Owner
Permit	C - Civil Engineer
Construction	CR - Contractor
Post Construction	A - Architect
	P - Plumbing Designer
	M - Mechanical Engineer
	E - Electrical Engineer
	L - Landscape Designer
	CxA - Commissioning Agent

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MARK	DATE	DESCRIPTION

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ARCHITECTS ENGINEERS CONNECTED

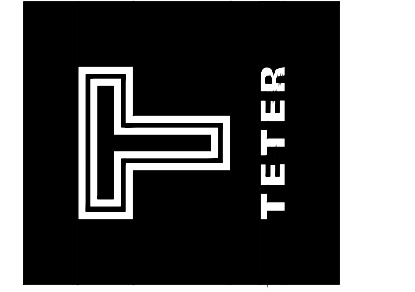


**NEW SHADE STRUCTURE
AT EXISTING AMPHITHEATER
BURRIS PARK FOUNDATION
KINGSBURG, CA**
DRAWING TITLE
CAL GREEN REQUIREMENTS

PROJECT NO.

23-12792

DRAWING

G001

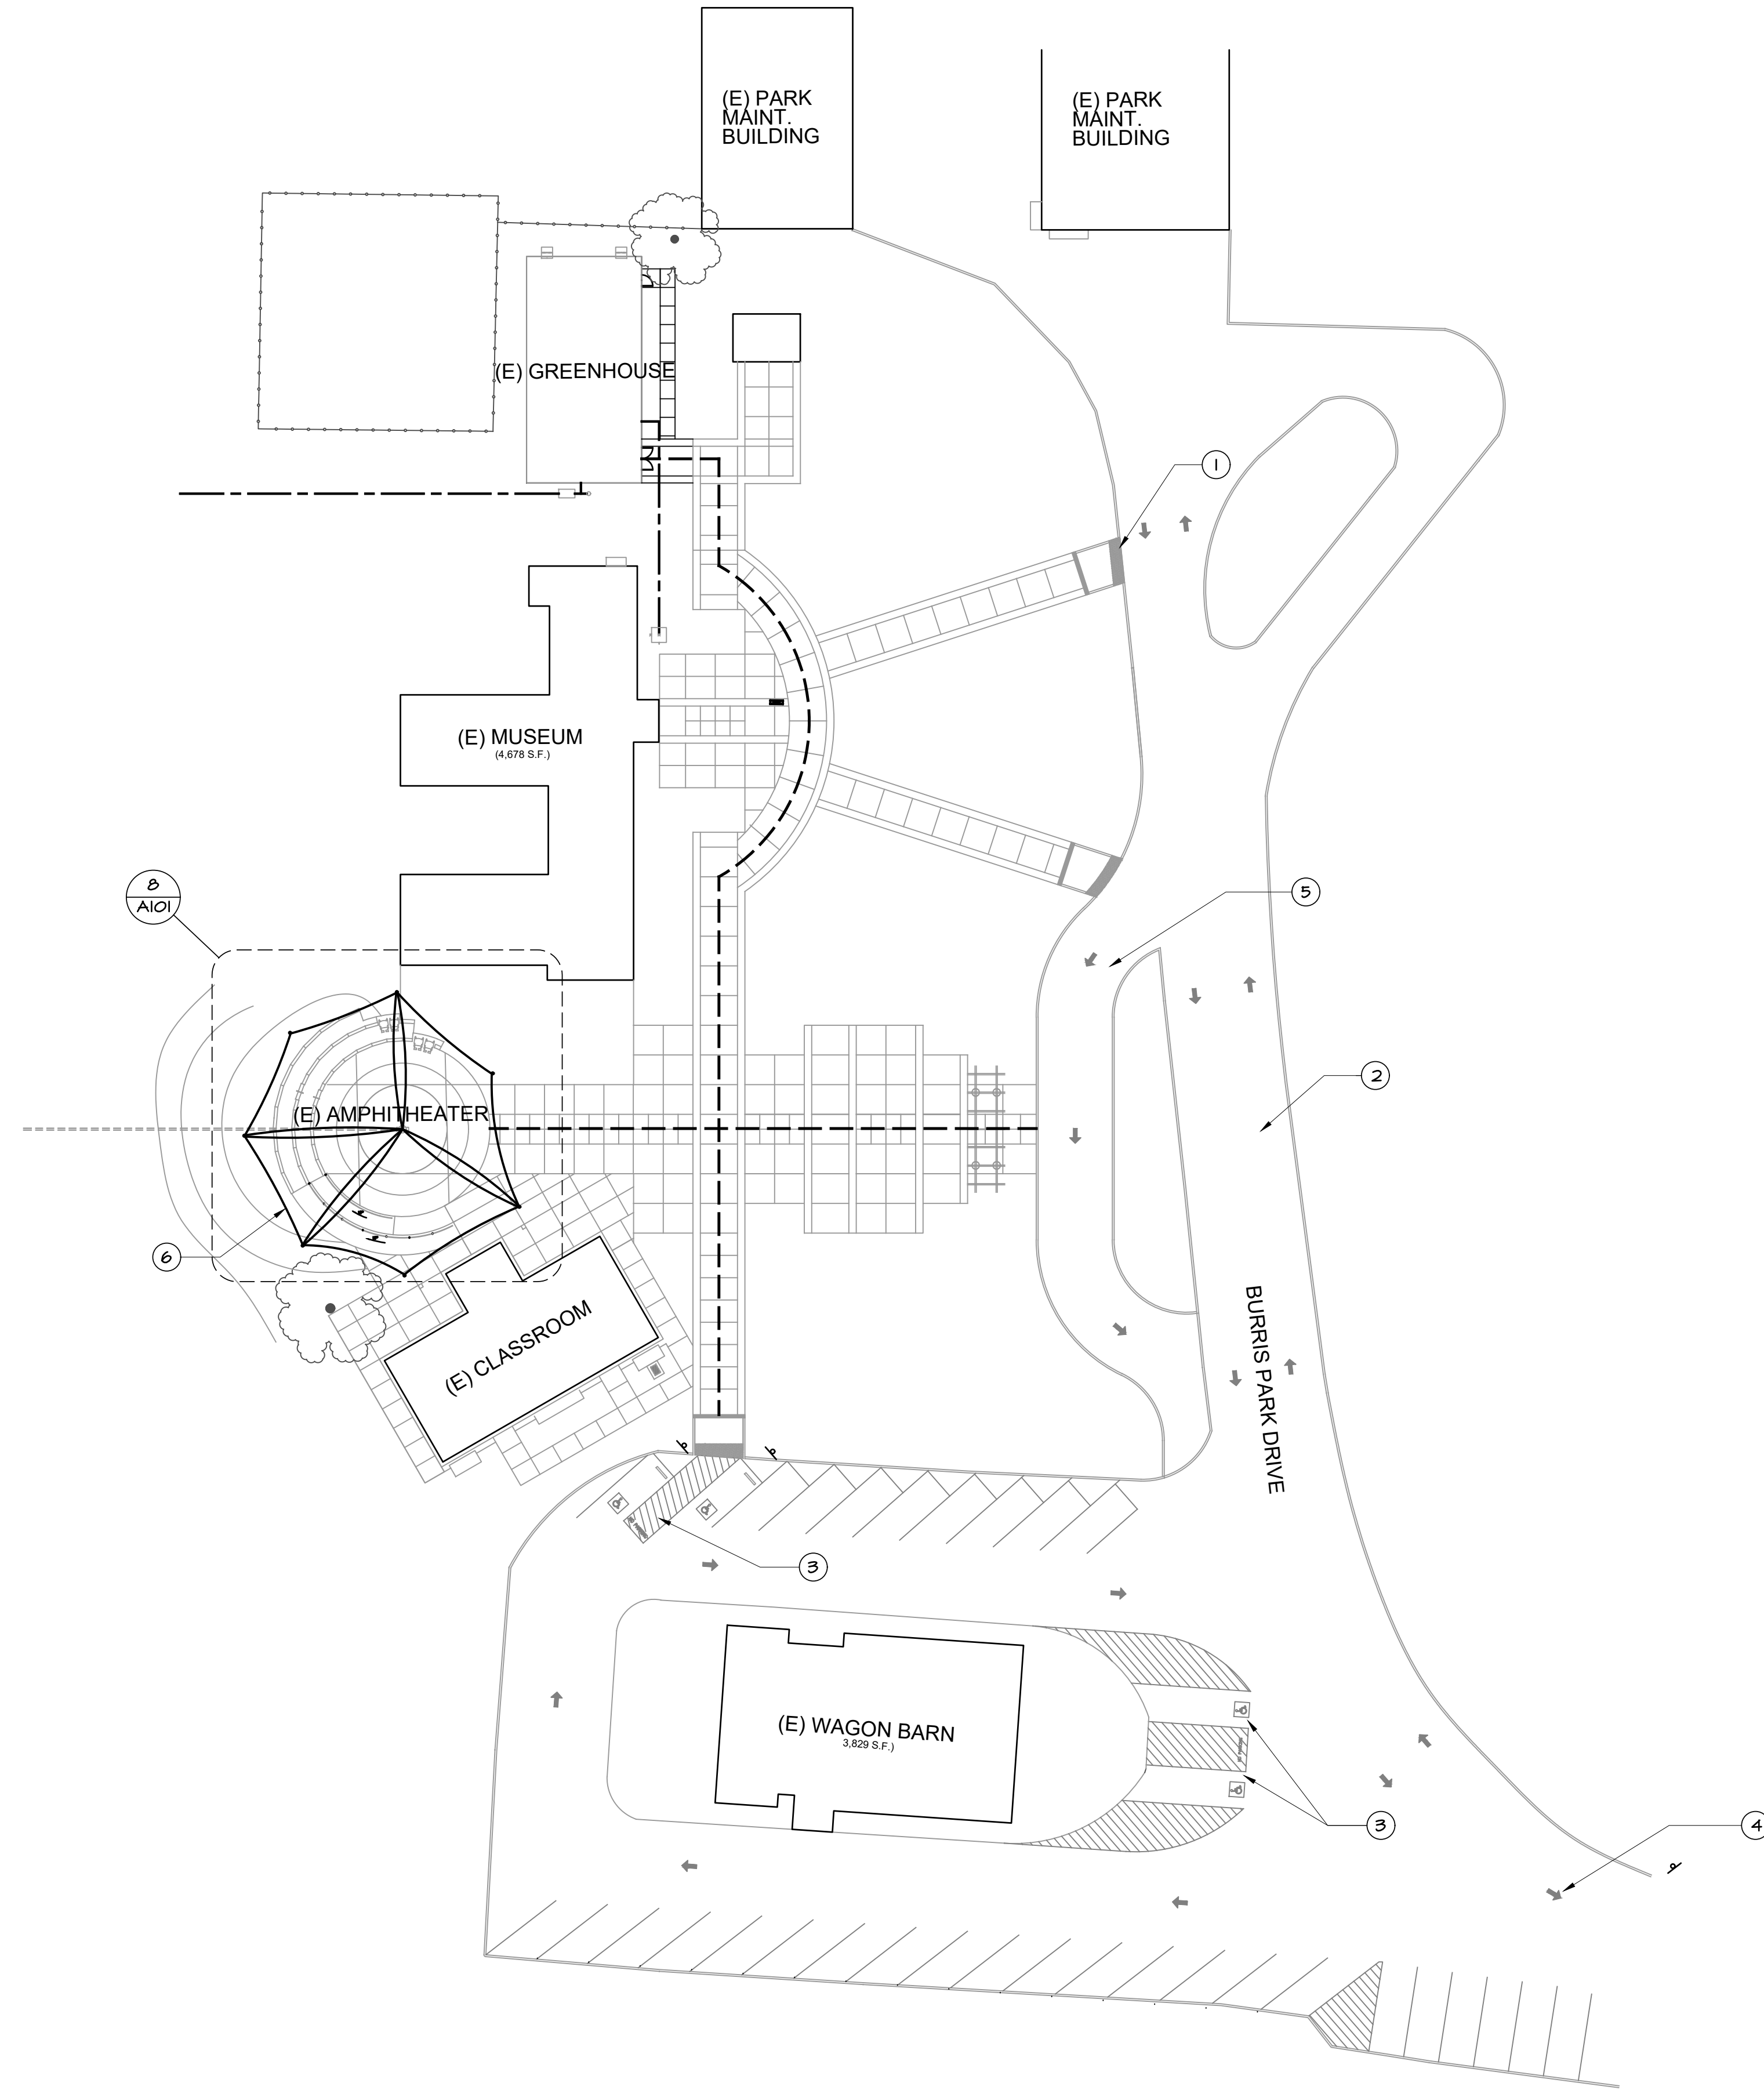

OVERALL SITE PLAN

SCALE: 1" = 30'-0"



KEYNOTES

- 1. EXISTING ACCESSIBLE PATH
- 2. EXISTING ROAD
- 3. EXISTING ACCESSIBLE PARKING
- 4. TO PUBLIC WAY
- 5. EXISTING ACCESSIBLE BUS DROP-OFF
- 6. NEW SHADE STRUCTURE AT AMPHITHEATER

LEGEND

----- ACCESSIBLE PATH OF ACCESS TRAVEL

**NEW SHADE STRUCTURE
AT EXISTING AMPHITHEATER
BURRIS PARK FOUNDATION**
KINGSBURG, CA


PROJECT NO.

23-12742

DRAWING

A100

DRAWING TITLE
OVERALL SITE PLAN

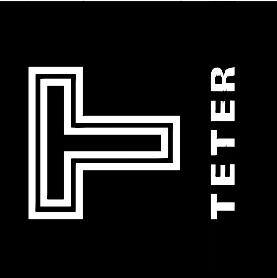

TETER, INC.

7555 N. PALM AVE. 201 | FRESNO, CA 93711 | 559.437.0887
 125 S. BRIDGE ST. 100 | VISALIA, CA 93291 | 559.425.5244
 1200 DISBURY DR. 100 | HANFORD, CA 93230 | 559.440.4466

ARCHITECTS ENGINEERS CONNECTED

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MARK	DATE	DESCRIPTION


NOTE: SHADE STRUCTURE SHAPE AND CONFIGURATION ARE EXAMPLES ONLY
FINAL DESIGN MAY VARY IN SHAPE, COVERAGE AND SUPPORT SYSTEMS.

(E) MUSEUM

(E) CLASSROOM

PARTIAL SITE PLAN - AMPHITHEATER

SCALE: 1/8" = 1'-0"

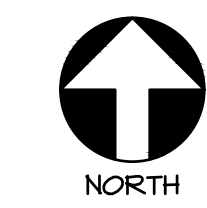

KEYNOTES #

1. EXISTING WOOD SEATING
2. EXISTING RAMP
3. BOTTOM SLOPED WALK
4. EXISTING GUIDE RAILING
5. EXISTING DECOMPOSED GRANITE
6. CENTERLINE ARC 48'-4"
7. EXISTING AREA DRAIN LEACH LINE, WORK WITH KINGS COUNTY MAINTENANCE AND/ OR POT HOLE TO CONFIRM LOCATION OF LINE, AVOID PLACING COLUMN ON DRAIN LINE.
8. EXISTING DRAIN INLET

LEGEND

(E) CONCRETE

ELEVATIONS

274.4(C) CONCRETE
274.7(E) EXISTING GRADE
274.4(N) NEW GRADE


SHADE DESIGN NOTES

DESIGN OF CANOPY SHALL BE SUCH THAT THE AMPHITHEATER WILL BE SHADED FROM 9:00 AM TO 3:00 PM, PACIFIC DAYLIGHT TIME, ON JUNE 21 ST OR THE SUMMER SOLSTICE.

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MARK	DATE	DESCRIPTION

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126 S. BRIDGE ST. 1301 | VISALIA, CA 93291 | 559-425-5244
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ARCHITECTS ENGINEERS CONNECTED

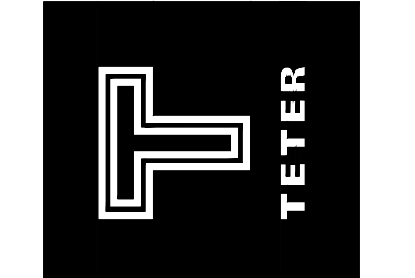

NEW SHADE STRUCTURE
AT EXISTING AMPHITHEATER
BURRIS PARK FOUNDATION
KINGSBURG, CA
DRAWING TITLE
PARTIAL SITE PLAN

PROJECT NO.
23-12712
DRAWING
A102